## 2825 W MERCER WAY PRELIMINARY PLAT

SE 28TH ST

OPEN SPACE

8,576 SF

**2** 8,452 SF


5' PRIVATE STORM DRAIN EASEMENT

14

8,572 SF

8,426 SF

8,459 SF

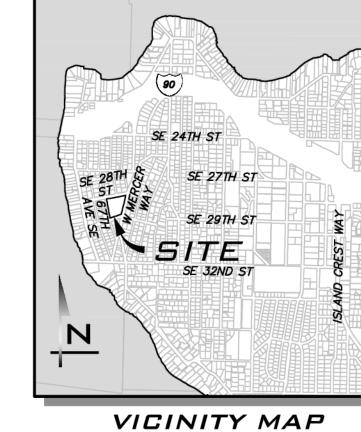

NOT TO SCALE

#### PROJECT TEAM

APPLICANT OB MERCER ISLAND PROPERTIES, LLC

P.O. BOX 726 101-116TH AVE SE BELLEVUE, WA 98009 (206) 604-7941 CONTACT: ERIC HANSEN EMAIL: ERIC@HANSENCRE.COM CIVIL ENGINEER THE BLUELINE GROUP 25 CENTRAL WAY, SUITE 400 KIRKLAND, WA 98033

(425) 250-7247 CONTACT: BRETT K. PUDISTS, PE EMAIL: BPUDISTS@THEBLUELINEGROUP.COM LANDSCAPE ARCHITECT

THE BLUELINE GROUP 25 CENTRAL WAY, SUITE 400 KIRKLAND, WA 98033 (425) 250-7230 CONTACT: TC COLLERAN, RLA

EMAIL: TCOLLERAN@THEBLUELINEGROUP.COM

SURVEYOR 4 SITE SURVEYING & CONSULTING 1336 57TH DRIVE SE,

AUBURN, WA 98092 (206) 832–9158 CONTACT: STEVEN AZELNTINE, PLS EMAIL: 4SITESURVEYING@COMCAST.NET ARBORIST

GREENFOREST INC 4547 S LUCILE ST SEATTLE, WA 98118 (206) 723-0656 CONTACT: FAVERO GREENFOREST EMAIL: GREENFORESTINC@MINDSPRING.COM

GEOTECHNICAL ENGINEER EARTH SOLUTIONS NW, LLC 1805 136TH PL NE, SUITE 201 BELLEVUE, WA 98005

(425) 449–4704 CONTACT: ADAM SHIER, GIT EMAIL: ADAM.SHIER@EARTHSOLUTIONSNW.COM

#### VERTICAL DATUM

CITY OF MERCER ISLAND

BENCHMARK

SANITARY SEWER MANHOLE AT INTERSECTION OF SE 28TH ST & 62ND AVE SE.

INVERT ELEVATION = 75.4

LEGAL DESCRIPTION BLOCKS 12 AND 13, EAST SEATTLE ADDITION PER PLAT RECORDED IN VOLUME 3 PAGES 22 AND 23, RECORDS OF KING COUNTY, WASHINGTON.

TOGETHER WITH VACATED 63RD AVENUE S.E. (VACATED

SUBJECT TO: EASEMENTS UTILITIES, RESTRICTIONS, RESERVATIONS, COVENANTS, AGREEMENTS, RIGHTS OF WAY AND ZONING, IF ANY, NOT SHOWN HEREON.

NOTE

PRELIMINARY DESIGN BY BLUELINE BASED ON SURVEY MAP PROVIDED BY 4 SITE SURVEYING & CONSULTING.

### SHEET INDEX

- 1 CV-01 COVER SHEET
- 2 EC-01 EXISTING CONDITIONS & DEMO PLAN
- 3 SP-01 SITE PLAN
- 4 GP-01 PRELIMINARY GRADING PLAN

SURVEY NOTES

1. ELEVATIONS, TREE LOCATIONS AND OTHER TOPOGRAPHIC

INFORMATION SHOWN HEREON HAVE BEEN LOCATED BY SINGLE

EDM MEASUREMENTS. WITH THE EXCEPTION OF CONTOUR LINES.

THE PURPOSE OF WHICH IS SHOW THE GENERAL CONFIGURATION

NORMALLY BE EXPECTED TO BE ACCURATE WITHIN 0.5 OF A FOOT HORIZONTALLY AND WITHIN 0.2 OF A FOOT VERTICALLY, HOWEVER.

OF THE GROUND AND THE FLOW OF WATER THEREFROM,

THERE IS ALWAYS THE POSSIBILITY OF A FEW ERRORS IN THE

TOPOGRAPHIC INFORMATION UNLESS EACH POINT IS LOCATED

AND THE ELEVATION IS DETERMINED FROM 2 DIFFERENT SURVEY CONTROL STATIONS. IT WOULD BE ADVISABLE TO MAKE A

PRELIMINARY LOCATION OF ANY PROPOSED IMPROVEMENTS ON

THE GROUND BEFORE FINAL PLANS AND CONTRACTS ARE MADE IN

ALL OF THE INFORMATION OBTAINED AND/OR DEVELOPED BY

INFORMATION IN RELATION TO THE PROPOSED CONSTRUCTION.

2. THE DRAWING SHOWN HEREON DOES NOT NECESSARILY CONTAIN

FIELD MEASUREMENTS OR IN THE OFFICE PLOTTING OF THE

ORDER TO VERIFY THE ACCURACY OF THE TOPOGRAPHIC

THE SURVEYOR IN HIS FIELD WORK, OFFICE WORK, OR

TOPOGRAPHIC INFORMATION LOCATED BY THIS METHOD CAN

- 5 UP-01 PRELIMINARY UTILITY PLAN
- 6 RS-01 PRELIMINARY ROAD PLAN & SECTIONS
- 7 RP-01 PRELIMINARY ROAD PROFILES
- 8 TR-01 PRELIMINARY TREE RETENTION AND REPLACEMENT PLAN
- 9 TR-02 TREE TABLES

1 OF 1 COMBINED TOPOGRAPHIC WORKSHEET

#### SITE DATA

SITE ADDRESS: TAX ACCOUNT NUMBER: GROSS SITE AREA: GROSS FLOOR AREA: NUMBER OF LOTS PROPOSED: PROPOSED USE: MINIMUM LOT SIZE ALLOWED:

SETBACKS:

LOT COVERAGE:

**BUILDING HEIGHT:** 


2825 W MERCER WAY 2174502425 2.88 ACRES (125,315.52 SF)

30' MAX ABOVE ABE

8,400 SF FRONT 20' (F), REAR 25' (R), SIDE 5' (S) (BUT 2 SIDE YARDS MUST EQUAL 15') ROW AND VEHICULAR ACCESS EASEMENT 10 40% MAX (LOT SLOPE LESS THAN 15%)

# UNDERGROUND UTILITY NOTE

UNDERGROUND UTILITIES ARE SHOWN IN THE APPROXIMATE LOCATION. THERE IS NO GUARANTEE THAT ALL UTILITY LINES ARE SHOWN, OR THAT THE LOCATION, SIZE AND MATERIAL IS ACCURATE. THE CONTRACTOR SHALL UNCOVER ALL INDICATED PIPING WHERE CROSSING, INTERFERENCES, OR CONNECTIONS OCCUR PRIOR TO TRENCHING OR EXCAVATION FOR ANY PIPE OR STRUCTURES. TO DETERMINE ACTUAL LOCATIONS, SIZE AND MATERIAL. THE CONTRACTOR SHALL MAKE THE APPROPRIATE PROVISION FOR PROTECTION OF SAID FACILITIES. THE CONTRACTOR SHALL NOTIFY <u>ONE CALL</u> AT 8-1-1 (WASHINGTON811.COM) AND ARRANGE FOR FIELD LOCATION OF EXISTING FACILITIES BEFORE CONSTRUCTION.

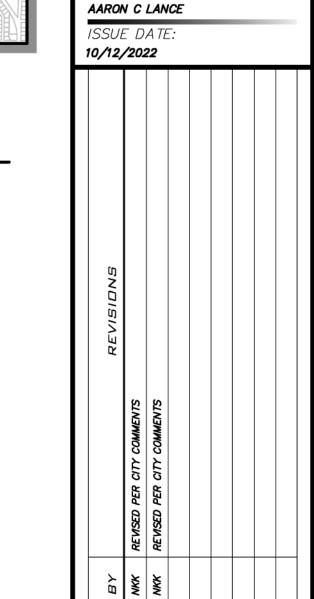

BLUELINE

KIRKLAND, WA 98033 P: 425.216.4051 F: 425.216.4052

WWW.THEBLUELINEGROUP.COM

PROJECT MANAGER: BRETT K PUDISTS, PE

PROJECT ENGINEER: LYNDSEY FEDAK, PE

AS NOTED

DESIGNER:



10/12/22

13-118 SHEET NAME: CV-01

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LOCATED 1/19 WGS

LEGEND EXISTING FEATURES

PROPOSED FEATURES

PROPOSED STORM DRAINAGE

PROPOSED SANITARY SEWER AND WATER

CENTERLINE

BUILDING FOOTPRINT

– AERIAL POWER LINE

--- -- LIMITS OF DISTURBANCE (LOD)

- WRE FENCE

BOARD FENCE DITCH OR SWALE

CATCH BASIN, TYPE I

CATCH BASIN, TYPE II

SD PIPE FLOW

SEWER MANHOLE SS PIPE FLOW

- FLOW & CURB

- CENTER LINE

— — — — — BUILDING SETBACK (BSBL)

——100——— 10' PROPOSED CONTOURS

——102——— 2' PROPOSED CONTOURS

---- ROOF & FOOTING DRAIN

RIPRAP PAD

STORM DRAIN PIPE

- VAULT OUTLINE

CATCH BASIN, TYPE I

- SEWER SERVICE

SEWER MANHOLE

SEWER CLEANOUT

✓ PIPE FLOW

- Buried Telephone Line

EASEMENT

— — — — — SURFACE FEATURES

— —100— — — 10' CONTOURS

----102---- 2' CONTOURS

— — — W — WATER MAIN

RETAINING WALL

---- SAWCUT

COCOCOCOCO ROCKERY

RETAINING WALL

**←** ··· **←** ··· SWALE OR DITCH

------- SEWER MAIN

— — — SD— **storm drain pipe** 

- ADJACENT PLAT/PARCEL LINE 🔍 FIRE HYDRANT

ADJACENT RIGHT-OF-WAY/LOTS = WATER METER

⋈ GATE VALVE

→ BLOW OFF

---> POWER POLE

← GUY ANCHOR

∷ STREET LIGHT

△ TRANSFORMER

**№ POWER METER** 

▼ TELECOMM JUNCTION BOX

GAS VALVE

**ASPHALT** 

CONCRETE

-RIGHT-OF-WAY

ASPHALT PAVEMENT

GRA VEL

— LOT LINE

MAILBOX

ZIN CURB RAMP

**★** ♦ STREET LIGHT

✓ PIPE FLOW

> CULVERT END

YARD DRAIN

**■** WATER METER

FIRE HYDRANT

● BLOW OFF

]M[ GATE VALVE

STORM CLEANOUT

CATCH BASIN, TYPE II

AIR/VAC RELEASE VALVE

 $\mathbf{H}$  TEE W/ CONC BLOCKING

↓── BEND W/ CONC BLOCKING

SIGN

FOUND 1" DIA. CONC. MON WITH 3/8" PLUG IN CASE LOCATED 1/19 WGS SURVEY

CONTROL #1086

SURVEY CONTROL #1092

N 10°09'32" W 408.41'—

<u>5' JOINT UTILITY</u> EASEMENT


8,415 SF

PRIVATE STORM DRAIN

8,403 SF

TRACT 999

(PRIVATE ACCESS & UTILITIES)

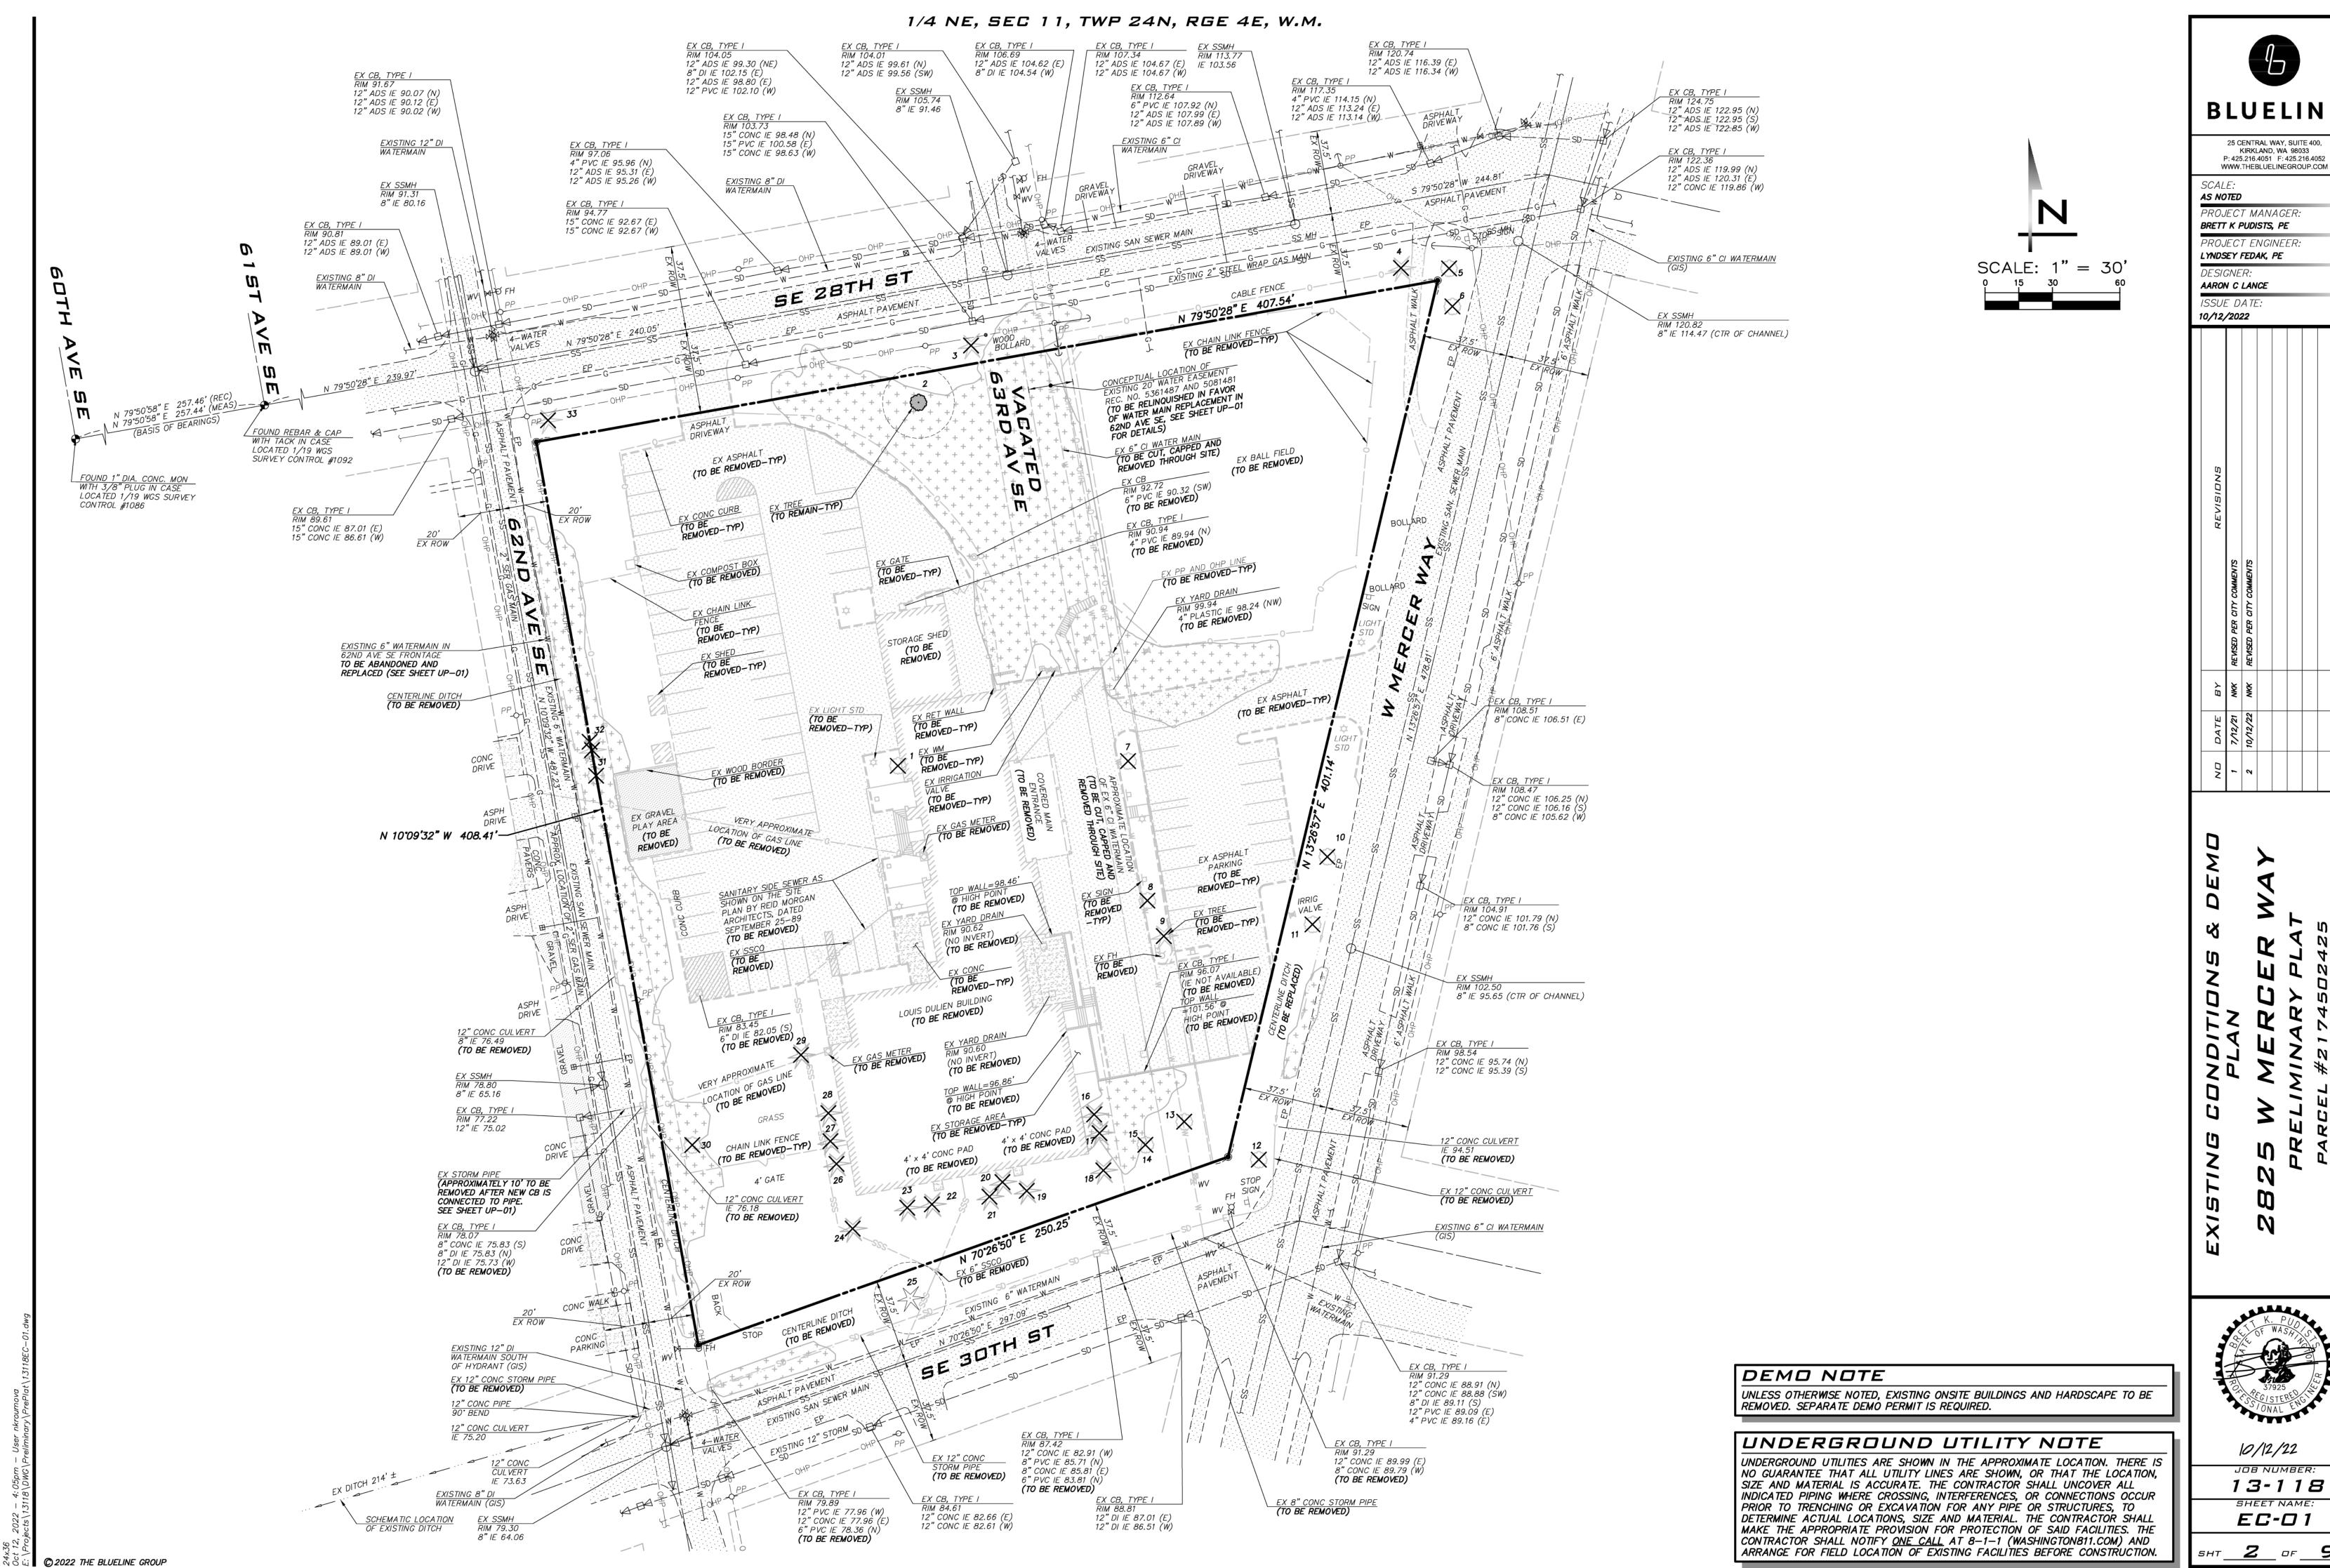


**BLUELINE** 


25 CENTRAL WAY, SUITE 400,


13-118 SHEET NAME: EC-01

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<u> </u>				
LOT NO.	LOT AREA (SF)	LOT COVERAGE (SF)*	LANDSCAPING AREA (SF)*	PORTION OF LANDSCAPING AREA THAT CAN BE HARDSCAPE (SF)**
1	8,576	3,430	5,146	772
2	8,452	3,381	5,071	761
3	8,572	3,429	5,143	771
4	8,459	3,384	5,075	761
5	8,415	3,366	5,049	757
6	8,403	3,361	5,042	756
7	8,490	3,396	5,094	764
8	8,455	3,382	5,073	761
9	8,400	3,360	5,040	756
10	8,400	3,360	5,040	756

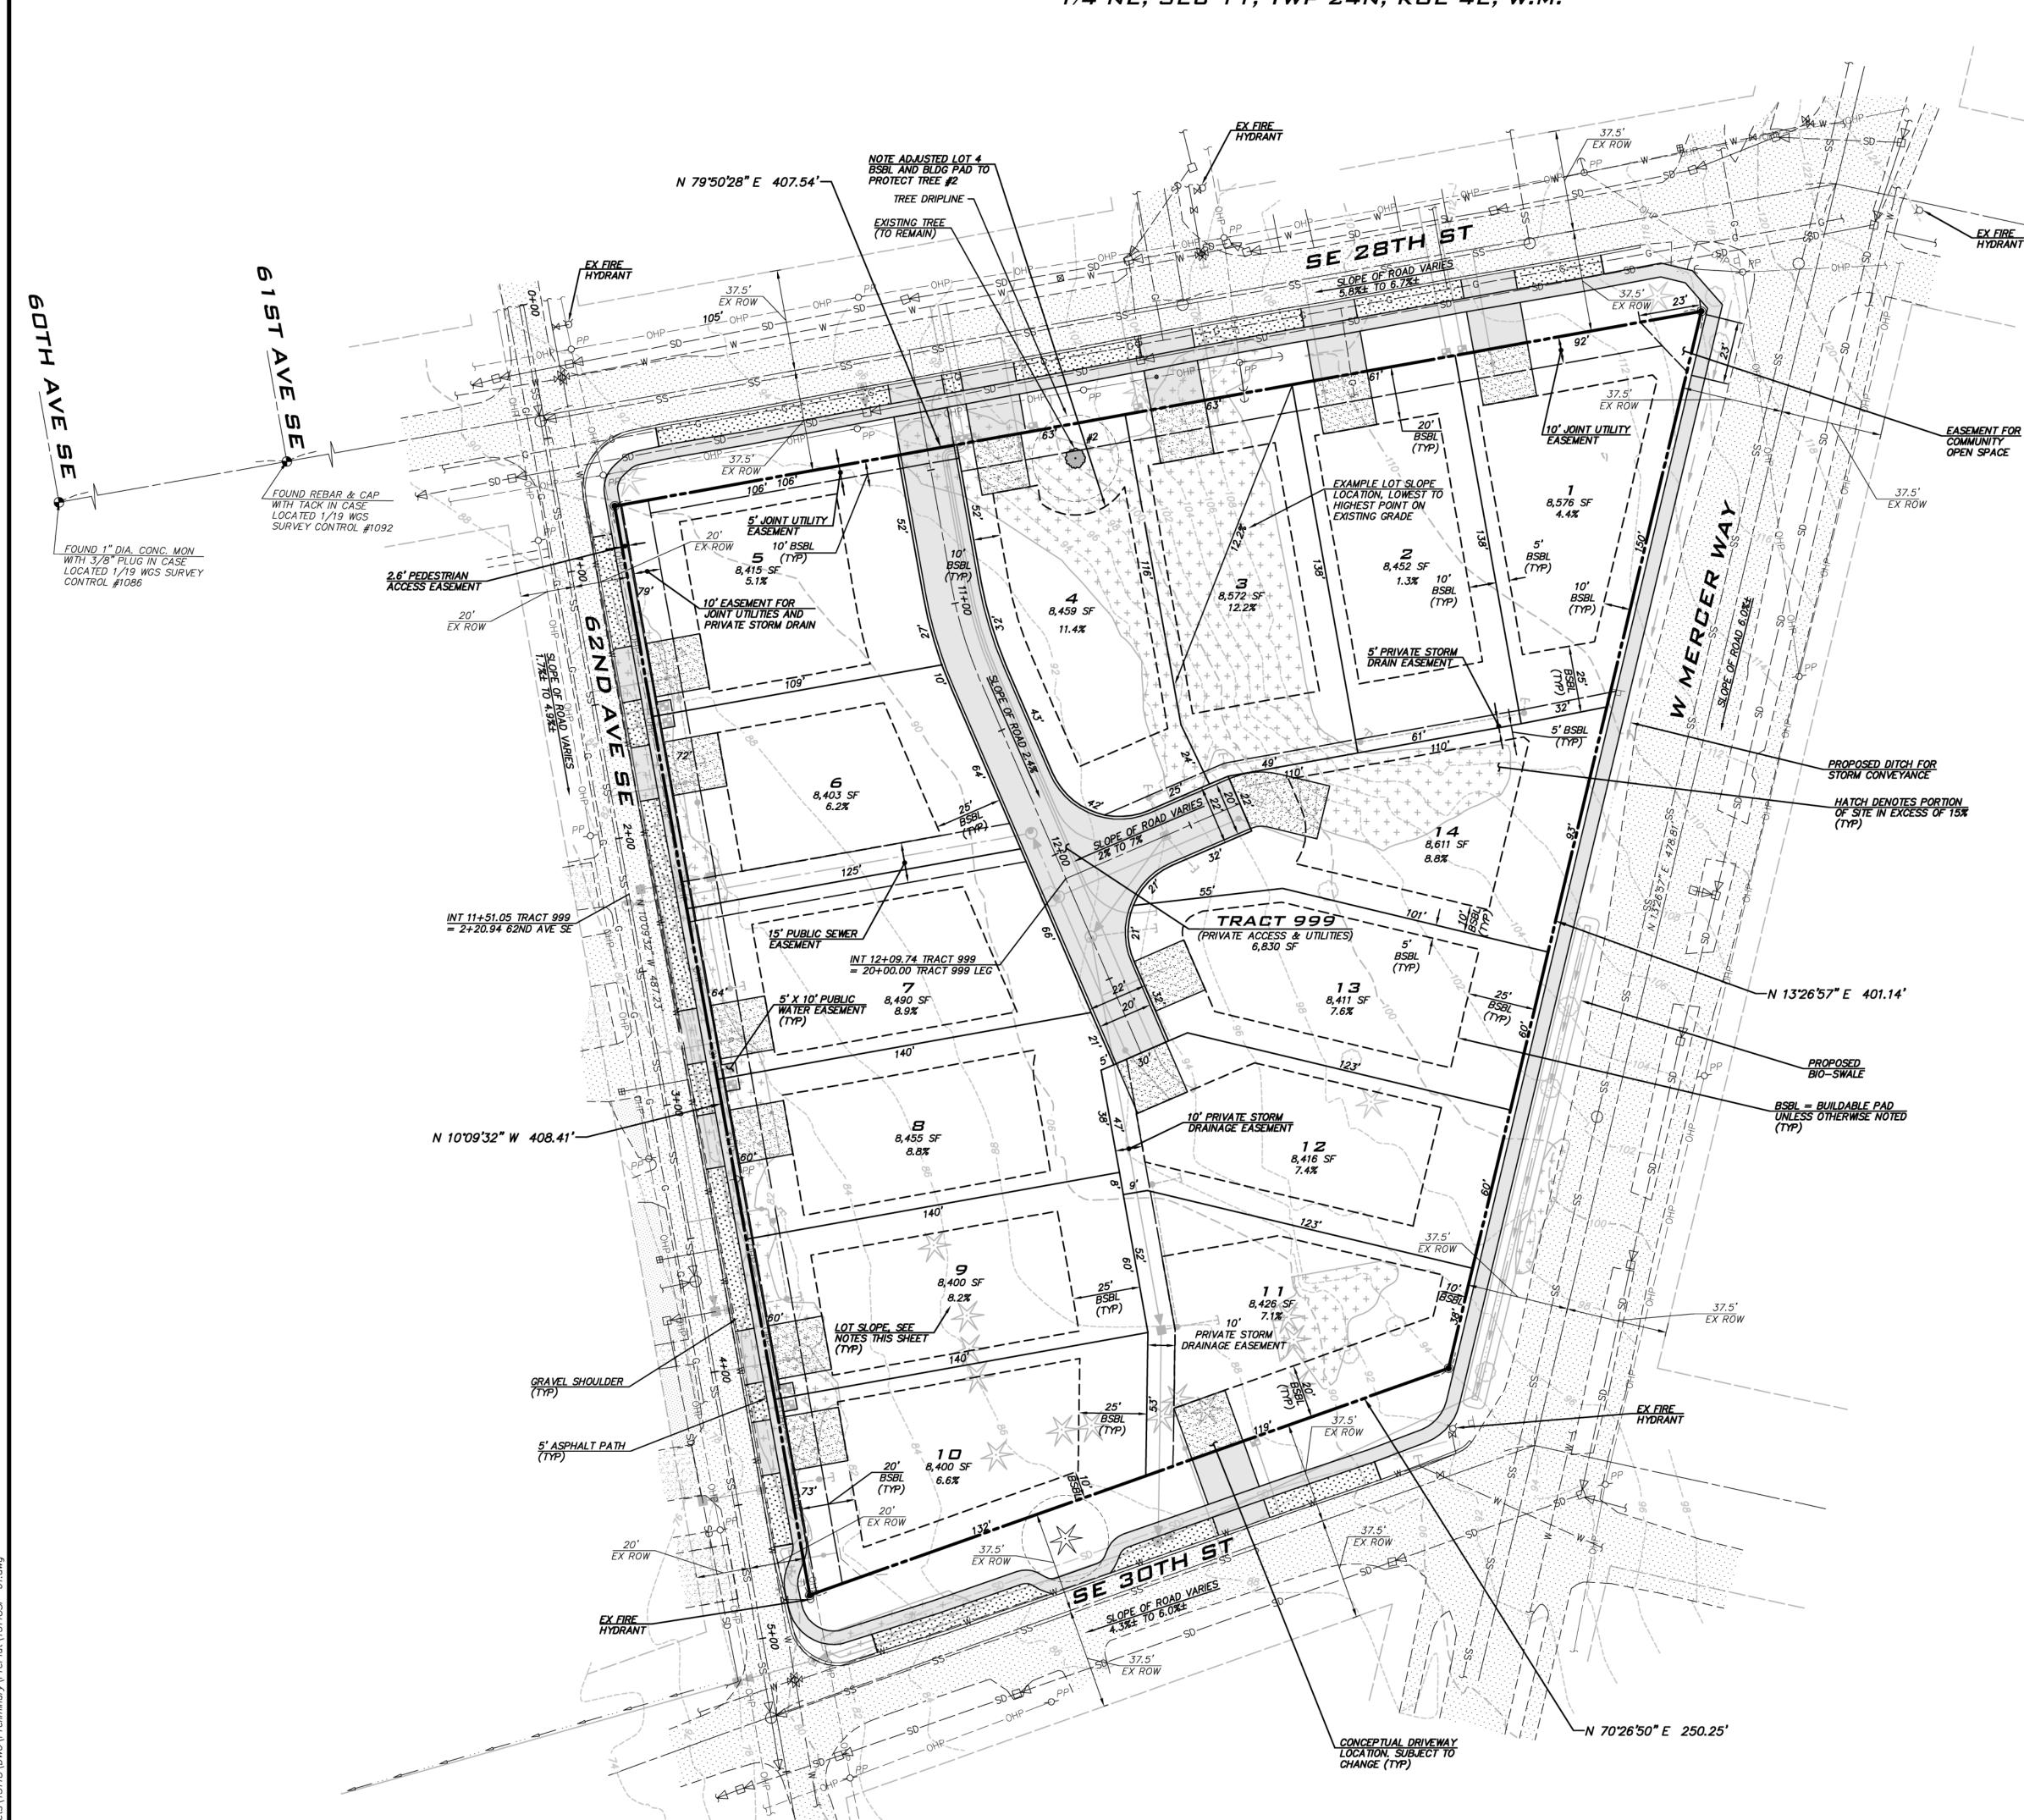LOT COVERAGE TABLE

\*LOT COVERAGE (40% OF THE LOT AREA) AND LANDSCAPING AREA (60% OF THE LOT AREA) ARE BASED ON THE EXISTING SLOPE IMPROVEMENTS, EXCEPT WHERE USED FOR HARDSCAPE IMPROVEMENTS. 9% OF THE LOT AREA MAY CONSIST OF

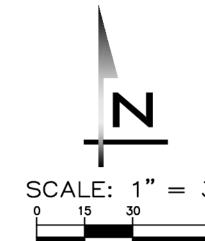5,050

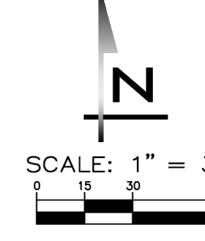5,167

#### FIRE SPRINKLERS

NEW SINGLE FAMILY RESIDENCES REQUIRE A MINIMUM OF 13D SPRINKLER SYSTEM.

#### LOT SLOPES

3,444

11 8,426 3,370

12 8,416

8,411 14 8,611

DENOTES AREAS OF SLOPE ≥ 15%.

SLOPE OF LOT =((HIGHEST LOT ELEVATION - LOWEST LOT ELEVATION) / HORIZONTAL DISTANCE) X 100

#### CRITICAL AREAS NOTE

NO CRITICAL AREAS WERE IDENTIFIED ON SITE.

#### NEAREST FIRE HYDRANT

EXISTING FIRE HYDRANTS ARE LOCATED NEAR EACH STREET INTERSECTION AND HAVE BEEN LABELED FOR CONVENIENCE.

#### BUILDING HEIGHTS

- PROPOSED BUILDINGS WILL BE DESIGNED IN THE FUTURE AS PART OF THE BUILDING PERMIT PROCESS.
- AVERAGE BUILDING ELEVATION GRADE POINTS TO BE
- DETERMINED BASED ON PROPOSED BUILDINGS BY OTHERS.

#### NOTES

- SEE LEGEND ON SHEET CV-01.
- REFER TO SHEET EC-01 FOR EXISTING FEATURES THAT WILL BE REMOVED.
- REFER TO SHEET GP-01 FOR PRELIMINARY GRADING PLAN.
- REFER TO SHEET UP-01 FOR PRELIMINARY UTILITY PLAN.
- SEE SHEET RS-01 FOR ROAD SLOPES AND CROSS SECTIONS.
- SEE SHEET TR-01 FOR TREE NUMBERS AND RETENTION SUMMARY.
- DIRECT VEHICULAR ACCESS TO W MERCER WAY IS PROHIBITED.

#### UNDERGROUND UTILITY NOTE

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**BLUELINE** 

25 CENTRAL WAY, SUITE 400, KIRKLAND, WA 98033 P: 425.216.4051 F: 425.216.4052 WWW.THEBLUELINEGROUP.COM

SCALE: AS NOTED PROJECT MANAGER:

BRETT K PUDISTS, PE PROJECT ENGINEER: LYNDSEY FEDAK, PE

DESIGNER: AARON C LANCE

ISSUE DATE: 10/12/2022

10/12/22

JOB NUMBER: 13-118 SHEET NAME: SP-01

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25 CENTRAL WAY, SUITE 400, KIRKLAND, WA 98033 P: 425.216.4051 F: 425.216.4052 WWW.THEBLUELINEGROUP.COM

SCALE: AS NOTED

PROJECT MANAGER: BRETT K PUDISTS, PE

PROJECT ENGINEER: LYNDSEY FEDAK, PE

DESIGNER: AARON C LANCE

ISSUE DATE:

ND DATE BY REVISED PER CITY COMMENTS
2 10/12/22 NKK REVISED PER CITY COMMENTS
3 10/12/22 NKK REVISED PER CITY COMMENTS

RCER WAY

25 W MERCER PRELIMINARY PLA

K. PUO WASH JOS 37925 37925 SONAL ENGLISHED


10/12/22


JOB NUMBER:
13-118


SHEET NAME:
GP-01


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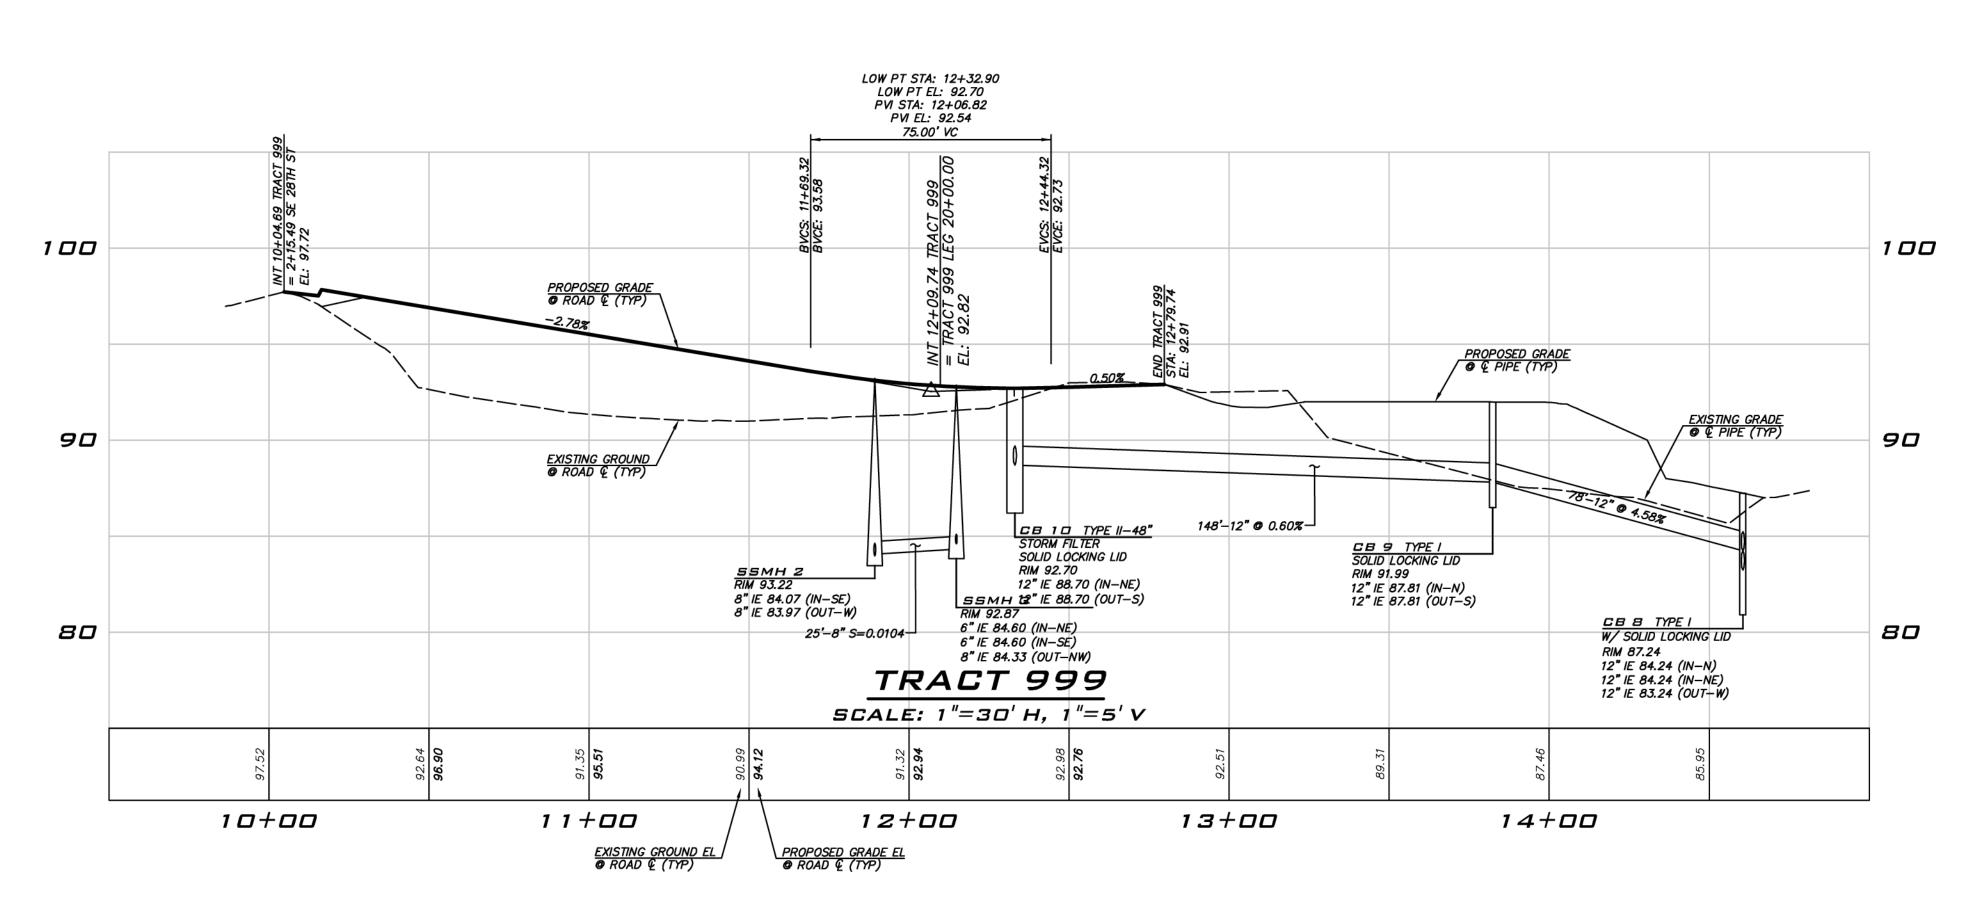
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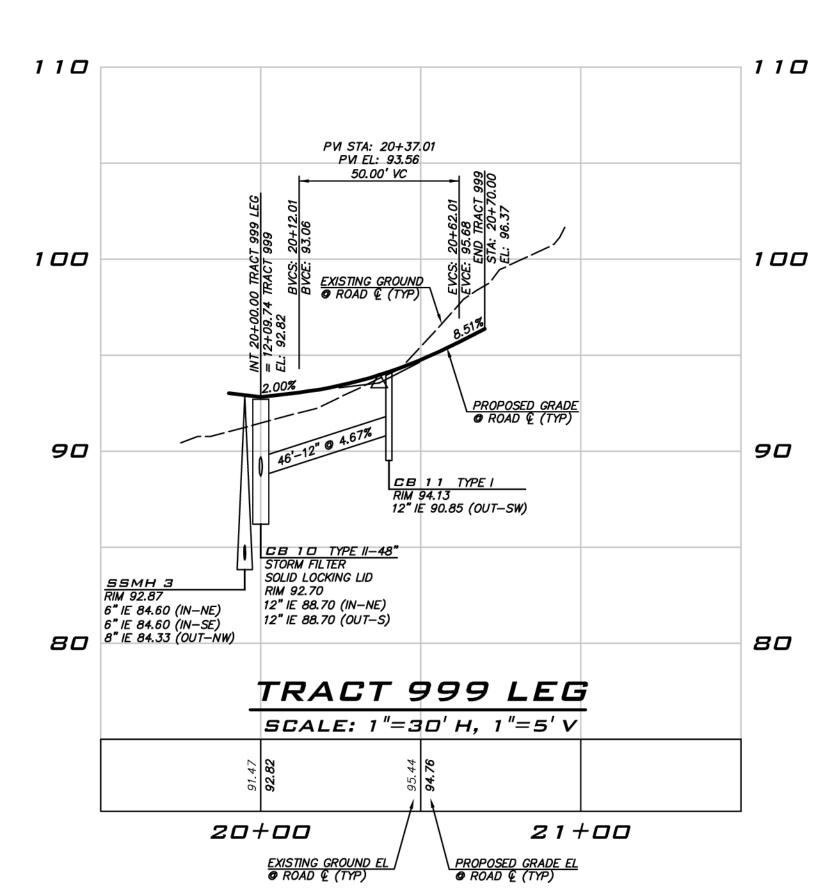




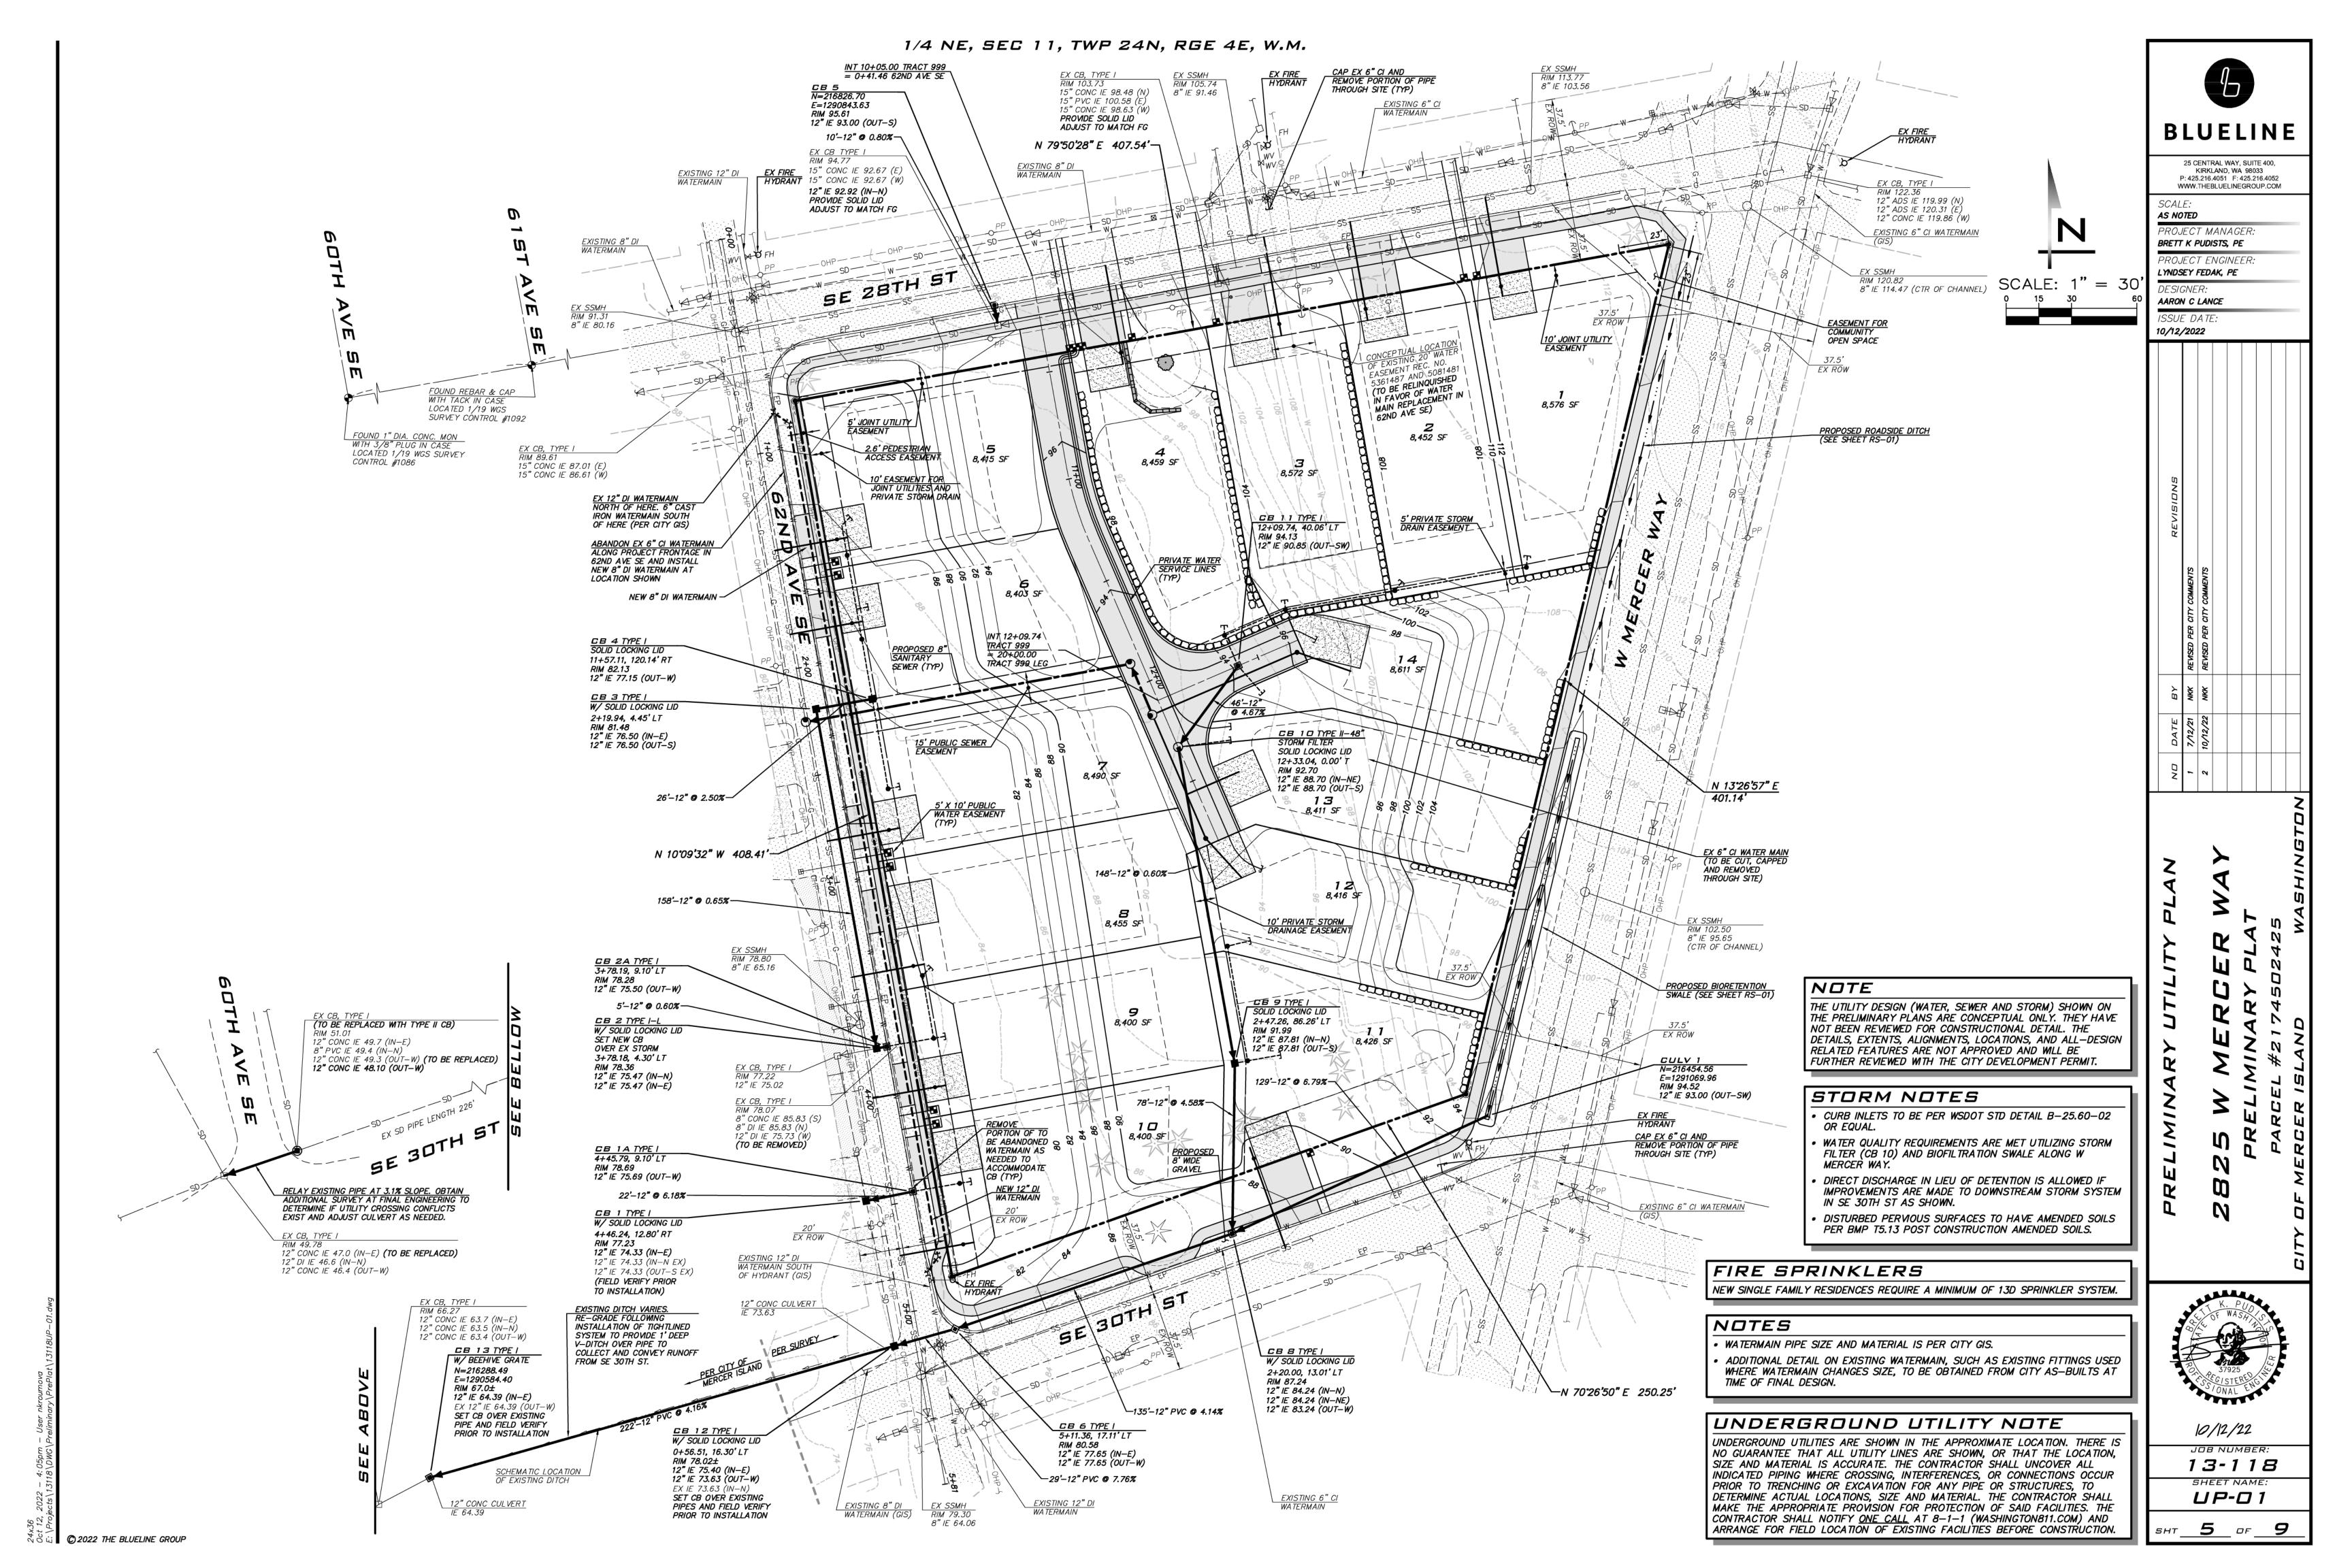

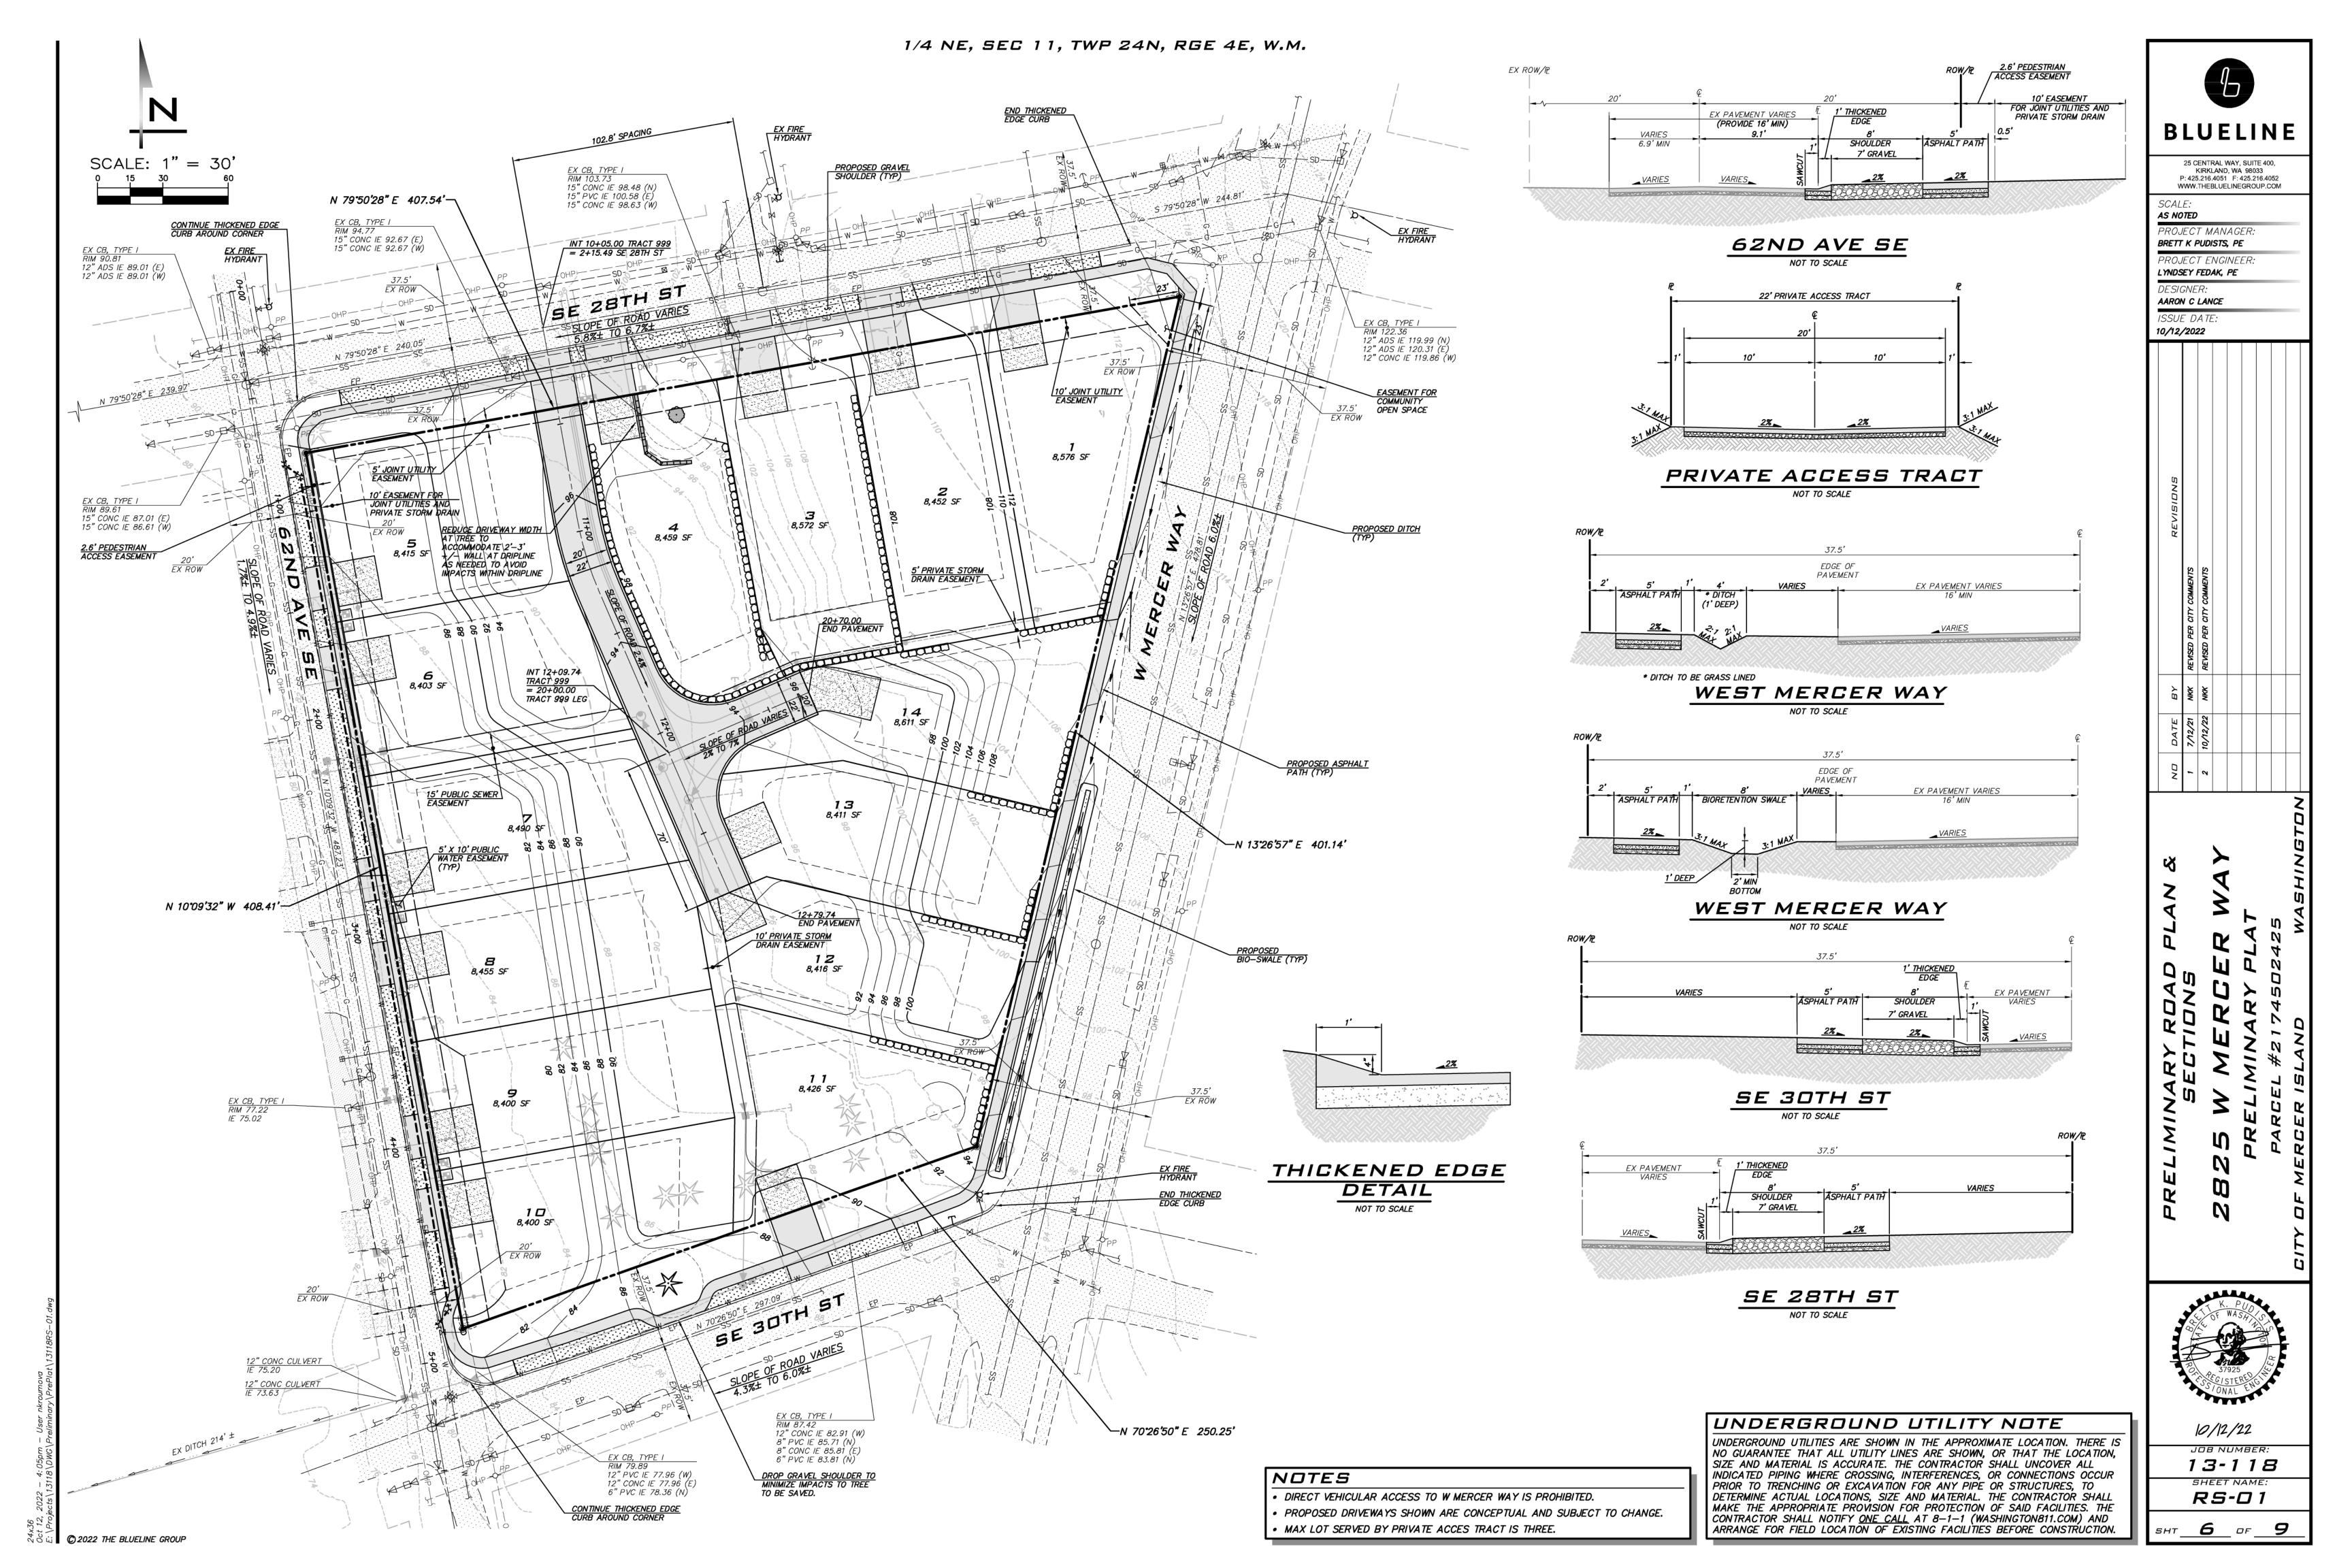

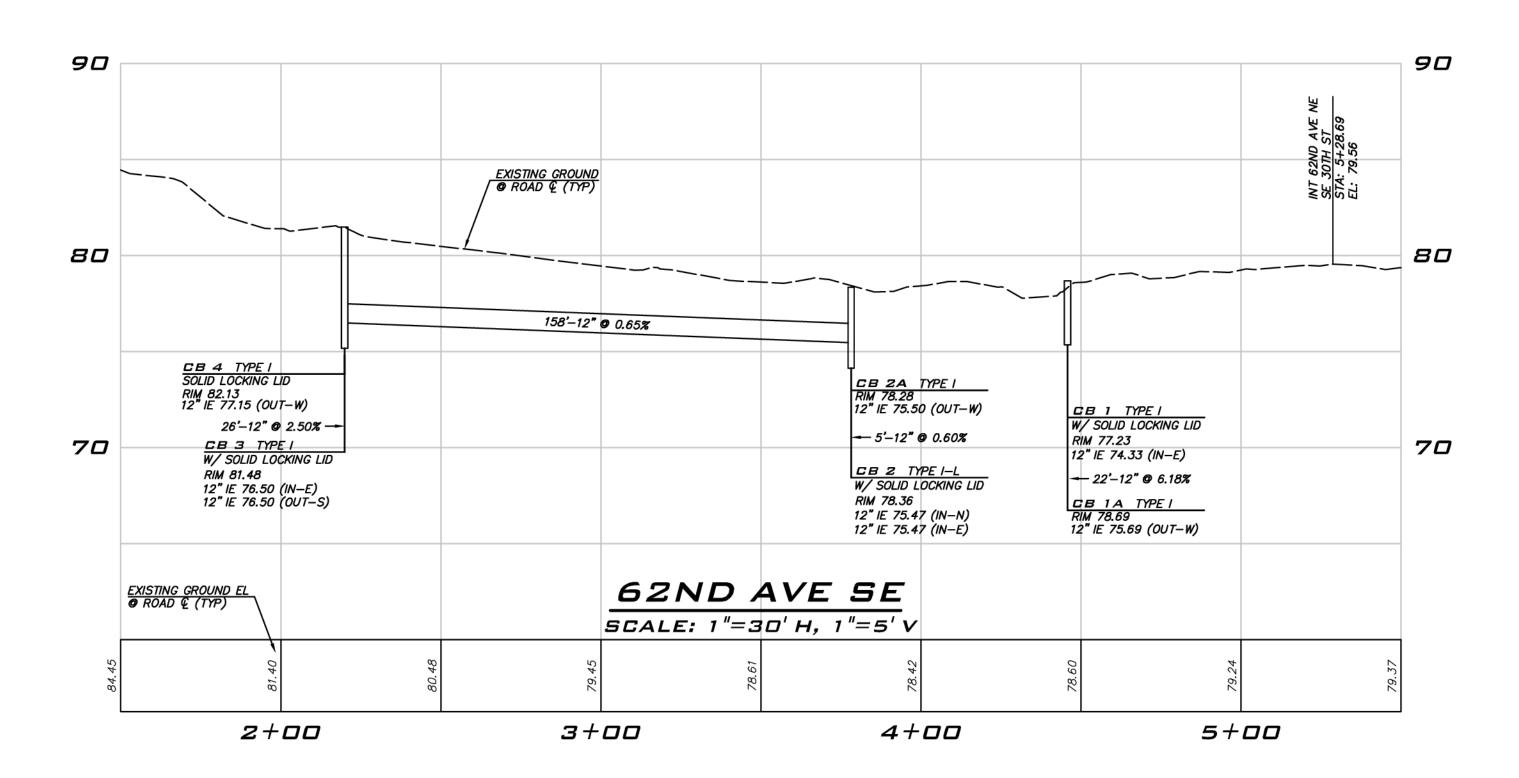

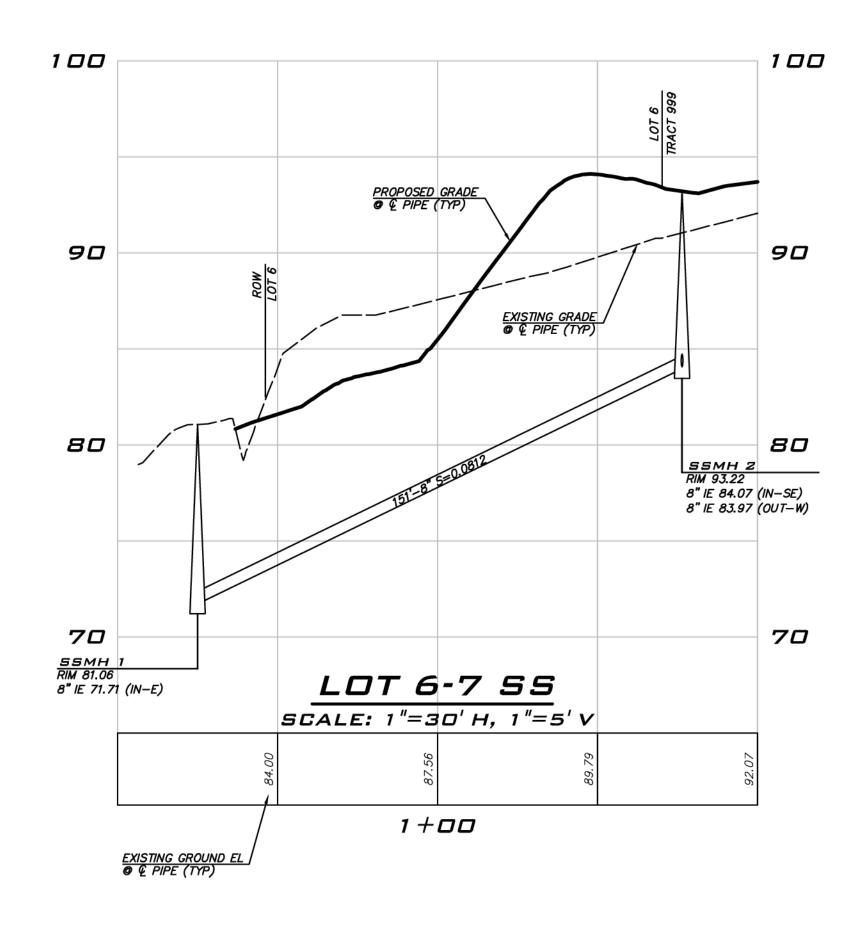

NOTE

NO DIRECT VEHICULAR ACCESS TO W MERCER WAY.

#### UNDERGROUND UTILITY NOTE

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BLUELINE

25 CENTRAL WAY, SUITE 400, KIRKLAND, WA 98033 P: 425.216.4051 F: 425.216.4052 WWW.THEBLUELINEGROUP.COM

SCALE: AS NOTED PROJECT MANAGER: BRETT K PUDISTS, PE PROJECT ENGINEER:


DESIGNER: AARON C LANCE

LYNDSEY FEDAK, PE 10/12/2022

10/12/22

13-118 SHEET NAME: RP-01

JOB NUMBER:

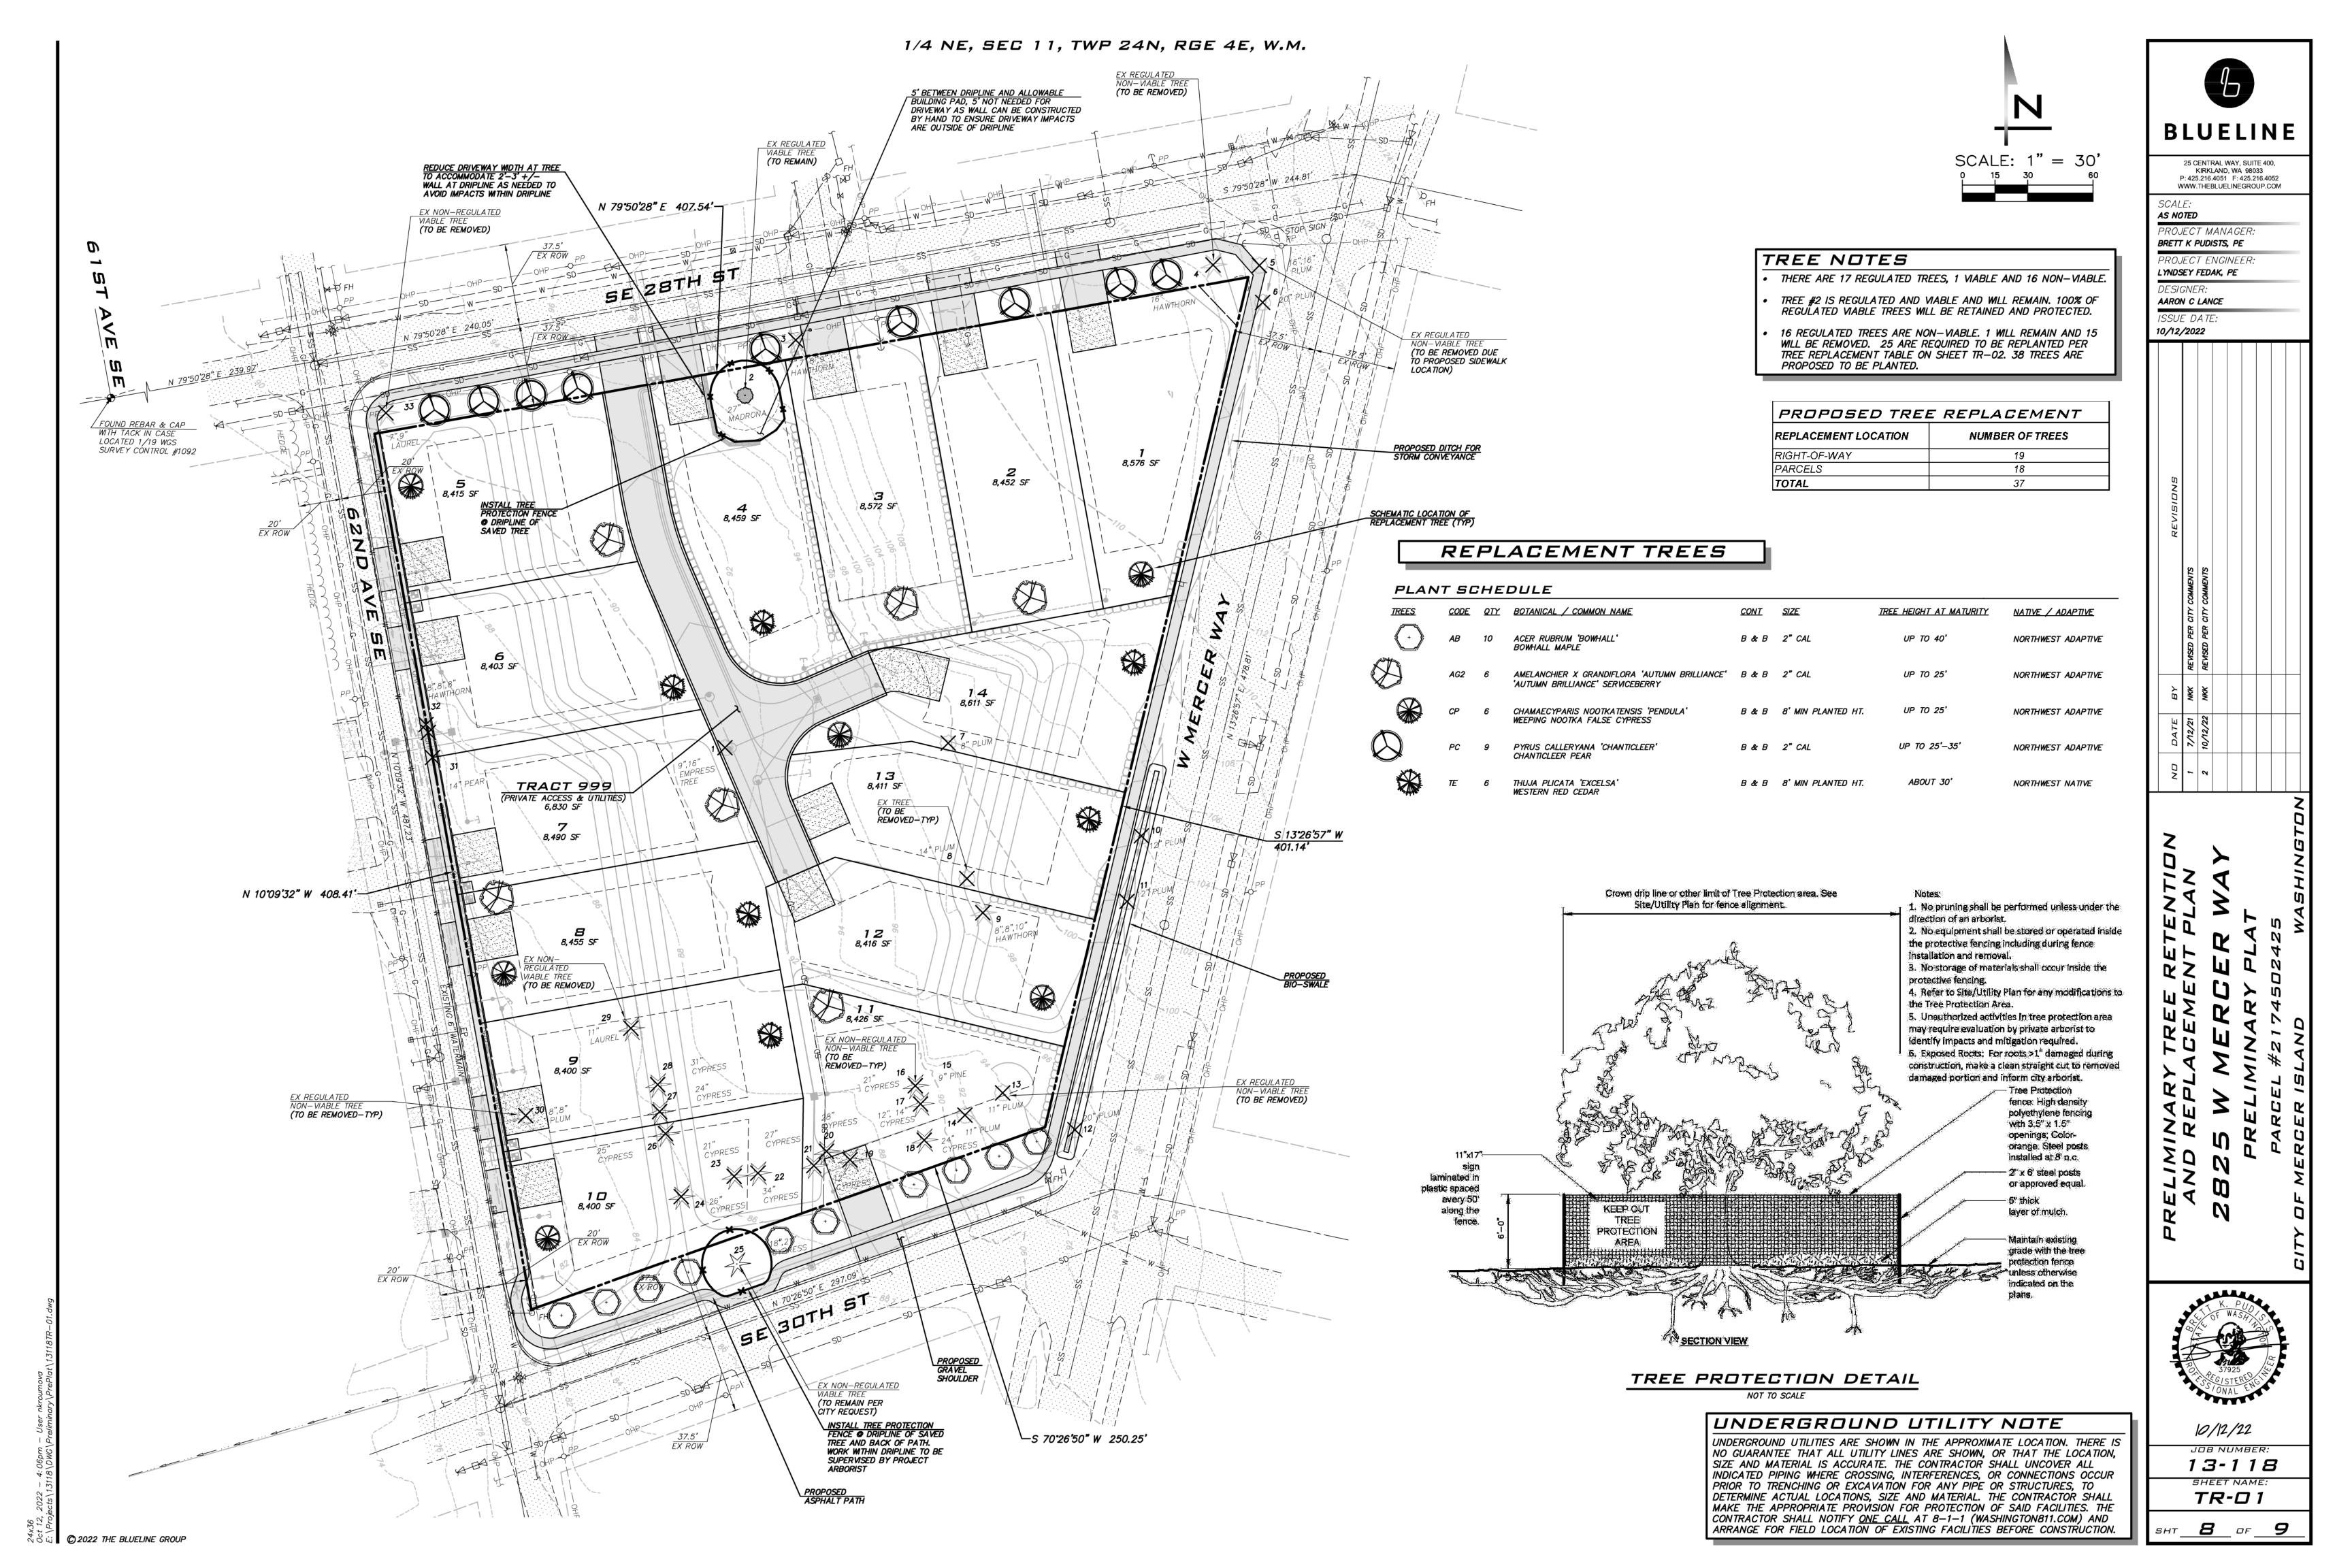

Mike O'Brien, OB Mercer Island Properties
RE: Arborist Report, 2825 West Mercer Way, Mercer Island WA
February 21, 2019
Page 10 of 11

NR = Not Regulated

Regulated Threshold	Regulated Category	≥24" DBH	Tree No.*	DBH (ln.)	QMD	Common name/Latin name	Dripline Radius	Health	Structure	Comments on Condition	Тгее Туре	Viable Tree?
NR			19	12"		Leyland cypress, Cupressus xLeylandii	16'	1	2		С	No
NR		Yes	20	28"		Leyland cypress, Cupressus xLeylandii	16'	1	2		С	No
NR		Yes	21	27"		Leyland cypress, Cupressus xLeylandii	16'	1	2		С	No
NR		Yes	22	34"		Leyland cypress, Cupressus xLeylandii	16'	1	2		С	No
NR			23	21"		Leyland cypress, Cupressus xLeylandii	16'	1	2		С	No
NR		Yes	24	26"		Leyland cypress, Cupressus xLeylandii	16'	1	2		С	No
NR		Yes	25	18,21"	27"	Leyland cypress, Cupressus xLeylandii	16'	1	1		С	Yes
NR		Yes	26	25"		Leyland cypress, Cupressus xLeylandii	16'	1	2		С	No
NR		Yes	27	24"		Leyland cypress, Cupressus xLeylandii	16'	1	2	Asymmetric (hedge against	С	No
NR		Yes	28	31"		Leyland cypress, Cupressus xLeylandii	16'	1	2	existing building)	С	No
NR			29	11"		Portugal laurel, Prunus lusitanica	10'	1	1		BE	Yes
36"	Significant		30	8,8"	11"	Plum (seedling), Prunus domestica	15'	3	3	Diseased, topped, decay, lean	D	No
36"	Significant		31	14"		Pear, common, Pyrus communis	16'	2	3	Topped, covered in ivy	D	No
16"	Significant		32	8,8,8"	13"	English hawthorn, Crataegus monogyna	15'	2	3	Multiple Idrs, lean, ivy	D	No
NR			33	7,9"	11"	Portugal laurel, Prunus Iusitanica	12'	1	2	Double leader	BE	Yes

Tree numbers are non-sequential because 3 small trees included in the previous inventory are removed from this report.

Greenforest

Registered C

Consulting Arborist

#### **CITY OF MERCER ISLAND**

**COMMUNITY PLANNING & DEVELOPMENT** 9611 SE 36TH STREET | MERCER ISLAND, WA 98040 PHONE: 206.275.7605 | www.mercergov.org



#### TREE INVENTORY & REPLACEMENT SUBMITTAL **INFORMATION**

List the total number			
	of trees for each category and the tree identification numbers from		report.
Number of trees 36"	or greater	0	
List tree numbers:			
Number of trees 24"	or greater (including 36" or greater)	1	
List tree numbers:	2		
Number of trees fror	n Exceptional Tree Table (MICC 19.16)	0	
List tree numbers:			
LARGE REGULATED T	REES		
definition of an Excep		ny tree that me 1	
Number of Large Reg	gulated Trees on site	ı	(A)
List tree numbers:			
List tree numbers: Number of Large Reg		0	(B)
List tree numbers:			
List tree numbers: Number of Large Reg List tree numbers:		0	
List tree numbers:  Number of Large Reg List tree numbers:	gulated Trees on site proposed for removal to be retained ((A-B)/Ax100) note: must be at least 30%		(B)
List tree numbers:  Number of Large Reg List tree numbers:  Percentage of trees to	gulated Trees on site proposed for removal to be retained ((A-B)/Ax100) note: must be at least 30%	100	(B) %
List tree numbers:  Number of Large Reg List tree numbers:  Percentage of trees to  RIGHT OF WAY TREE  Right of Way Trees - r	gulated Trees on site proposed for removal to be retained ((A-B)/Ax100) note: must be at least 30%	100	(B) %

List tree numbers:	
Reason for removal:	

#### TREE REPLACEMENT

Tree replacement- removed trees must be replaced based on the ratio in the table below. Replacement trees shall be conifers at least six feet tall and or deciduous at least one and one-half inches in diameter at

			Number of Tree
	Tree	Number of	Required for
Diameter of Removed Tree (measured 4.5'	replacement	Trees Proposed	Replacement Based
above ground)	Ratio	for Removal	on Size/Type
Less than 10" and non-viable trees	1	13	13
10" up to 24"	2	0	0
Greater than 24" up to 36"	3	0	0
Greater than 36" and any Exceptional Tree	6	2	12
	TOTAL TRE	25 required	

37 provided

\\chfs1\share\CPD\FORMS\1Current Forms\Engineering Forms\TreeInventoryReplacementSubmittalInformation.docx 1/2019

# BLUELINE

25 CENTRAL WAY, SUITE 400, KIRKLAND, WA 98033 P: 425.216.4051 F: 425.216.4052

WWW.THEBLUELINEGROUP.COM SCALE: AS NOTED

PROJECT MANAGER: BRETT K PUDISTS, PE PROJECT ENGINEER:

LYNDSEY FEDAK, PE DESIGNER:

AARON C LANCE

10/12/2022

13-118 SHEET NAME: TR-02

UNDERGROUND UTILITIES ARE SHOWN IN THE APPROXIMATE LOCATION. THERE IS NO GUARANTEE THAT ALL UTILITY LINES ARE SHOWN, OR THAT THE LOCATION, SIZE AND MATERIAL IS ACCURATE. THE CONTRACTOR SHALL UNCOVER ALL INDICATED PIPING WHERE CROSSING, INTERFERENCES, OR CONNECTIONS OCCUR PRIOR TO TRENCHING OR EXCAVATION FOR ANY PIPE OR STRUCTURES, TO DETERMINE ACTUAL LOCATIONS, SIZE AND MATERIAL. THE CONTRACTOR SHALL MAKE THE APPROPRIATE PROVISION FOR PROTECTION OF SAID FACILITIES. THE CONTRACTOR SHALL NOTIFY ONE CALL AT 8-1-1 (WASHINGTON811.COM) AND ARRANGE FOR FIELD LOCATION OF EXISTING FACILITIES BEFORE CONSTRUCTION.